**PROJECT:** 

# HOFFMAN ESTATES FIRE STATION 22

2190 W HIGGINS RD, HOFFMAN ESTATES, IL 60169


**OWNER:** 

# VILLAGE OF HOFFMAN ESTATES

1900 HASSELL RD, HOFFMAN ESTATES, IL 60169

**ISSUANCE:** 

ISSUED FOR BID/PERMIT PHASE 1 -- September 4, 2025

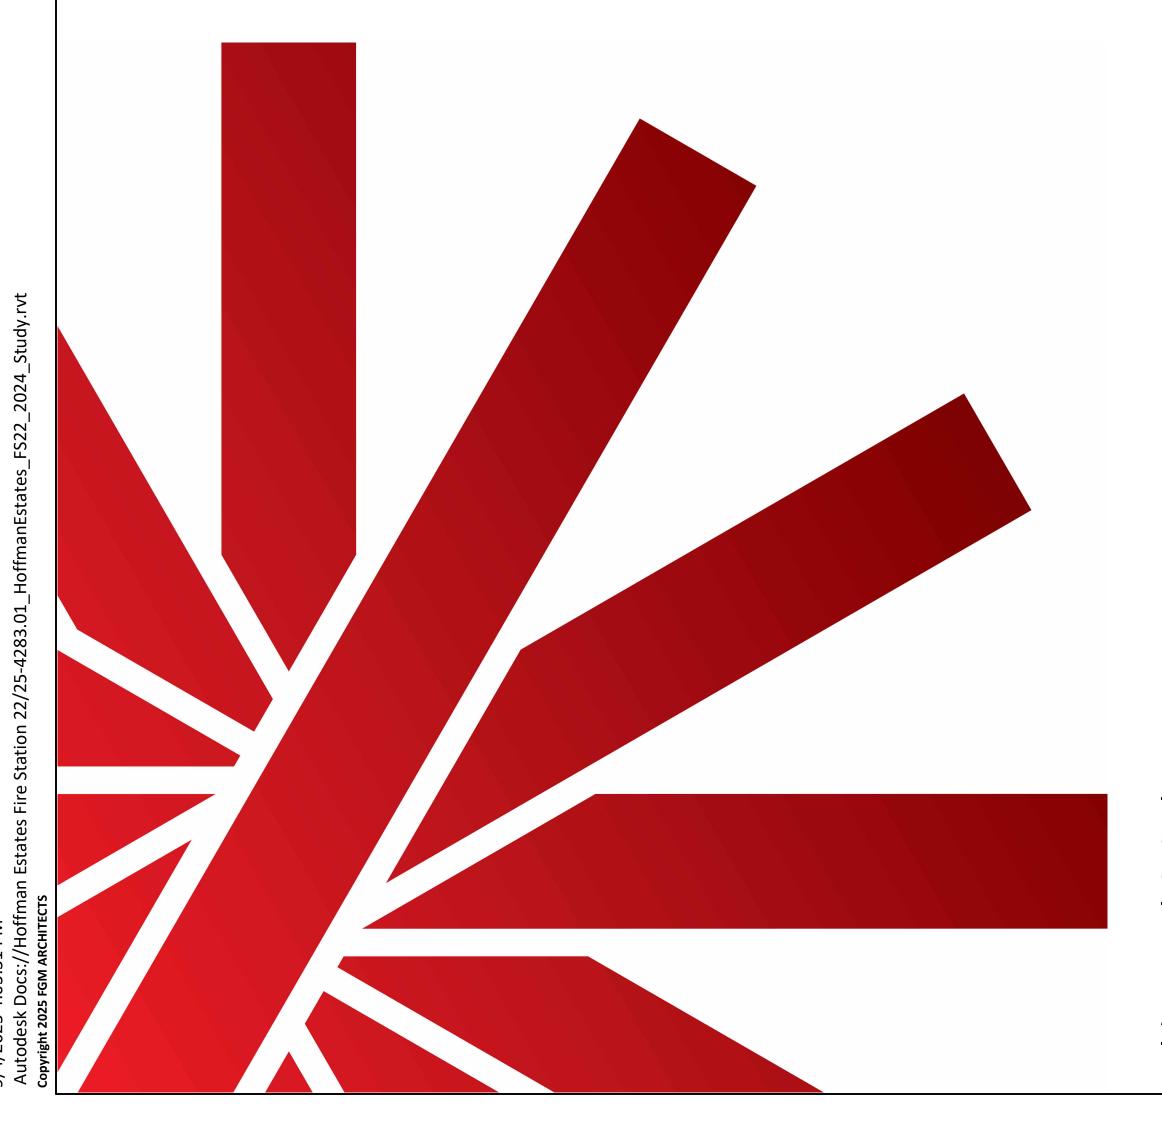

THIS SET OF DRAWINGS MARKED "ISSUED FOR CONSTRUCTION - [XXXX XX, XXXX]" IS BEING PROVIDED AS A CONVENIENCE TO THE CONTRACTORS AND DOES NOT MODIFY THE CONTRACT BETWEEN THE CONTRACTOR AND THE OWNER. IN CASE OF DISCREPANCIES, THE CONTRACT DOCUMENTS INCLUDING THE DRAWINGS ISSUED FOR BIDDING, ALL ADDENDA AND OTHER CONTRACT MODIFICATIONS, SHALL TAKE PRECEDENCE OVER THIS ISSUED FOR CONSTRUCTION SET.

# <u>ARCHITECT</u>

### **FGM Architects**

1 Westbrook Corporate Center Suite 1000

Westchester, Illinois 60154 Phone: 630.574.8300 www.fgmarchitects.com



**FGMA**RCHITECTS

# **CIVIL**

# PINNACLE ENGINEERING GROUP

1051 E Main Street
East Dundee, Illinois, 60118
Phone: 847.551.5300



# **CONSTRUCTION MANAGER**

Camosy Construction 43451 N US Hwy 41 Zion, Illinois 60099 Phone: 847.395.6800 Fax: 847.395.6891

SHEET NUMBER	SHEET NAME					
GENERAL						
G0.0	COVER SHEET					
G1.0	PLAT OF SURVEY					
CIVIL C1 C2	COVER SHEET EXISTING CONDITIONS					
C3	DEMOLITION PLAN					
C4	SITE STABILIZATION PLAN					
C5	CONSTRUCTION STANDARDS					
SITE						
AD0.1	DEMOLITION SITE PLAN					
AD0.2	CONSTRUCTION STAGING SITE PLAN					



1 VICINITY MAP

NOT TO SCALE



2 LOCATION MAP

NOT TO SCALE

FGM Architects

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Suite 1000
Westchester, Illinois 60154

630.574.8300 OFFICE

ILLINOIS PROFESSIONAL DESIGN

PINNACLE ENGINEERING GROU 1051 E MAIN ST EAST DUNDEE, ILLINOIS, 60118 847.551.5300 (0) IL STATE CERTIFICATE OF AUTHORITY NO. 184.006289-0010035.03296

ANDREW JOHN
JASEK
001-019548

EXP 11/20/2-6

2025-09-04 ISSUE FOR BID/PERMIT

**FATES FIRE STATION 22**1AN ESTATES
D, HOFFMAN ESTATES, IL 60169

VILLAGE OF HOFFMAN ESTATES 2190 W HIGGINS RD, HOFFMAN EST

**COVER SHEET** 

SHEET NO.

**G**0.0

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PINNACLE ENGINEERING GROUP
1051 E MAIN ST
EAST DUNDEE, ILLINOIS, 60118
847.551.5300 (O)
IL STATE CERTIFICATE OF AUTHORITY
NO. 184.006289-0010035.03296

**PLAT OF SURVEY** 

**G1.0** 

# HOFFMAN ESTATES FIRE STATION 22

2190 W. HIGGINS ROAD HOFFMAN ESTATES, ILLINOIS 60169

**PLANS PREPARED** 

1 WESTBROOK CORPORATE CENTER **SUITE 1000** WESTCHESTER, ILLINOIS 60154

**LOCATION MAP** 

### **GENERAL NOTES** NGS MONUMENT COO53 1B DESCRIBED AS LOCATED APPROXIMATELY 1.3 MI SOUTHEAST OF PALATINE IN

- 1. THE VILLAGE OF HOFFMAN ESTATES COMMUNITY DEVELOPMENT DEPARTMENT SHALL BE NOTIFIED 48 HOURS PRIOR TO COMMENCEMENT OF WORK AND 24 HOURS PRIOR TO EACH
- 2. ALL UTILITY COMPANIES, INCLUDING VILLAGE OF HOFFMAN ESTATES, SHALL BE CONTACTED AND THEIR FACILITIES SHALL BE LOCATED PRIOR TO ANY WORK IN ANY EASEMENT, RIGHT-OF-WAY, OR SUSPECTED UTILITY LOCATION. REPAIR OF ANY DAMAGE TO EXISTING FACILITIES SHALL BE RESPONSIBILITY OF THE CONTRACTOR. UTILITY LOCATIONS SHOWN HEREIN ARE FOR GRAPHIC ILLUSTRATION ONLY AND ARE NOT TO BE RELIED UPON.
- 3. PRIOR TO COMMENCEMENT OF ANY OFFSITE CONSTRUCTION, THE CONTRACTOR SHALL SECURE WRITTEN AUTHORIZATION THAT ALL OFFSITE EASEMENTS HAVE BEEN SECURED, AND THAT PERMISSION HAS BEEN GRANTED TO ENTER ONTO PRIVATE PROPERTY.
- 4. EXCEPT WHERE MODIFIED BY THE CONTRACT DOCUMENTS, ALL WORK PROPOSED HEREON SHALL BE IN ACCORDANCE WITH THE FOLLOWING SPECIFICATIONS (LATEST EDITION):
- a. THE MUNICIPAL CODE AND STANDARDS OF VILLAGE OF HOFFMAN ESTATES. b. "STANDARD SPECIFICATIONS FOR ROAD AND BRIDGE CONSTRUCTION" BY ILLINOIS DEPARTMENT OF TRANSPORTATION.
- c. "SUPPLEMENTAL SPECIFICATIONS AND RECURRING SPECIAL PROVISIONS" BY ILLINOIS DEPARTMENT OF TRANSPORTATION.
- d. "STANDARD SPECIFICATIONS FOR TRAFFIC CONTROL ITEMS" BY ILLINOIS DEPARTMENT OF TRANSPORTATION.
- e. "MANUAL ON UNIFORM TRAFFIC CONTROL DEVICES" (M.U.T.C.D.) LATEST EDITION.
- f. "STANDARD SPECIFICATIONS FOR WATER AND SEWER MAIN CONSTRUCTION IN ILLINOIS" BY ILLINOIS SOCIETY OF PROFESSIONAL ENGINEERS, ET AL. g. OTHER STANDARDS OR SPECIFICATIONS SPECIFICALLY REFERRED TO IN AN INDIVIDUAL PROVISION OF THESE STANDARDS AND SPECIFICATIONS.
- h. "ILLINOIS RECOMMENDED STANDARDS FOR SEWAGE WORKS" AS PUBLISHED BY THE I.E.P.A.

i. "ILLINOIS URBAN MANUAL" AS PREPARED BY THE U.S. DEPT. OF AGRICULTURE & IL. ASSOCIATION OF SOIL AND WATER CONSERVATION DISTRICTS

- j. THE CONTRACT DOCUMENTS, GENERAL CONDITIONS, SPECIAL PROVISIONS AND SUPPLEMENTAL CONDITIONS OF THE PROJECT AS PREPARED BY PINNACLE ENGINEERING
- k. ALL DOCUMENTS CITED IN THE ABOVE STANDARDS AND SPECIFICATIONS RELEVANT TO THE SUBJECT UNDER CONSIDERATION. IF A CONFLICT ARISES BETWEEN ANY PROVISION(S) OF THE REFERENCE ITEMS ABOVE AND ANY PROVISION(S) OF THESE STANDARDS AND SPECIFICATIONS, THEN THE MORE RESTRICTIVE PROVISION(S) SHALL

UPON COMPLETON OF THE PROJECT, THE DEVELOPER SHALL PROVIDE FINAL "RECORD DRAWINGS" (DIGITAL CAD AND PDF FILES, PLUS 1 MYLAR SEPIA REPRODUCIBLE. SIGNED AND SEALED BY THE ENGINEER) OF ALL INFORMATION NECESSARY FOR PERMIT CONSENT AND MUNICIPAL ACCEPTANCE. THIS MAY INCLUDE (BUT NOT LIMITED TOO) UTILITIES WHICH INCLUDE THE LOCATIONS AND ELEVATIONS OF MAINS, SERVICE LINES, STRUCTURES, PAVED AREAS, SITE GRADING (INCLUDE ADA AREAS), STORMWATER FACILITIES, STREET LIGHTS, CURBS AND MONUMENTS. FINAL DRAWINGS MUST ALSO INCLUDE A STATE PLANE COORDINATE SYSTEM TIE-IN. IN ADDITION TO THE DRAWINGS, AN ELECTRONIC FILE (IN DWG OR DGN FORMAT) OF THE RECORD DRAWINGS MUST BE SUBMITTED ON CD-ROM.


# **INDEX OF SHEETS**

- COVER SHEET **EXISTING CONDITIONS**
- **DEMOLITION PLAN**
- SITE STABILIZATION PLAN
- CONSTRUCTION STANDARDS

DRAINAGE CERTIFICATE

I, BRIAN JOHNSON, HEREBY CERTIFY THAT ADEQUATE STORM WATER STORAGE AND DRAINAGE CAPACITY HAS BEEN PROVIDED FOR THIS DEVELOPMENT, SUCH THAT SURFACE WATER FROM THE DEVELOPMENT WILL NOT BE DIVERTED ONTO AND CAUSE DAMAGE TO THE ADJACENT PROPERTY FOR STORMS UP TO AND INCLUDING THE ONE HUNDRED (100) YEAR EVENT, AND THAT THE DESIGN PLANS ARE IN COMPLIANCE WITH ALL APPLICABLE STATE, COUNTY, AND

PERMIT SET

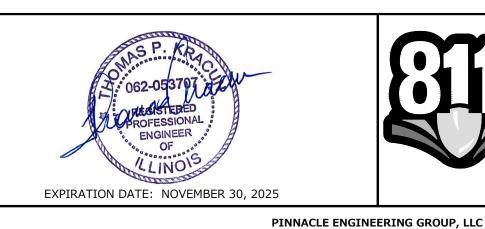

Formerly JULIE 1-800-892-01

**ENGINEER'S LIMITATION** OF THE DELIVERABLES HEREIN BEYOND A REASONABLE DILIGENCE. IF ANY MISTAKES, OMISSIONS, OR DISCREPANCIES ARE FOUND TO EXIST WITHIN THE DELIVERABLES. THE ENGINEER SHALL BE PROMPTLY NOTIFIED PRIOR TO BID SO THAT THEY MAY HAVE THE OPPORTUNITY TO TAKE WHATEVER STEPS NECESSARY TO RESOLVE THEM. FAILURE TO PROMPTLY NOTIFY THE ENGINEER OF SUCH CONDITIONS SHALL ABSOLVE THE ENGINEER FROM ANY RESPONSIBILITY FOR THE CONSEQUENCES OF SUCH FAILURE. ACTIONS TAKEN WITHOUT THE KNOWLEDGE AND CONSENT TO THE ENGINEER, OR IN CONTRADICTION TO THE ENGINEER'S DELIVERABLES OR RECOMMENDATIONS, SHALL BECOME THE RESPONSIBILITY NOT OF THE ENGINEER BUT OF THE PARTIES RESPONSIBLE FOR TAKING SUCH

FURTHERMORE, PINNACLE ENGINEERING GROUP, LLC IS NOT RESPONSIBLE FOR CONSTRUCTION SAFETY OR THE MEANS AND METHODS OF

**FGM Architects** 

Suite 1000

FIRM #184-000350

OAK BROOK, ILLINOIS 60523 847.551.5300 (O)

IL STATE CERTIFICATE OF AUTHORITY

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Westchester, Illinois 60154

**ILLINOIS PROFESSIONAL DESIGN** 

630.574.8300 OFFICE

PINNACLE ENGINEERING GROUP

ISSUANCE

DESCRIPTION

2025-09-04 ISSUED FOR BID/PERMIT

**LEGEND** 

SANITARY MANHOLE

CONCRETE HEADWALL

PRECAST FLARED END SECTION

STORM MANHOLE

CATCH BASIN

VALVE VAULT

VALVE BOX

FIRE HYDRANT

**BUFFALO BOX** 

FORCE MAIN

WATER MAIN

LIGHTING

OR PEDESTAL

POWER POLE

**GUY WIRE** 

GAS MAIN

CONTOUR

WETLANDS

FLOODWAY

FLOODPLAIN

DITCH OR SWALE

DIVERSION SWALE

SOIL BORING

TOPSOIL PROBE

FENCE LINE, WIRE

CONCRETE SIDEWALK

CURB AND GUTTER

DEPRESSED CURB

EASEMENT LINE

PROPERTY LINE

HIGH WATER LEVEL (HWL)

NORMAL WATER LEVEL (NWL)

DIRECTION OF SURFACE FLOW

OVERFLOW RELIEF ROUTING

FENCE LINE, TEMPORARY SILT

FENCE LINE, CHAIN LINK OR IRON

FENCE LINE, WOOD OR PLASTIC

REVERSE PITCH CURB & GUTTER

TREE WITH TRUNK SIZE

STREET SIGN

TELEPHONE LINE

SPOT ELEVATION

STORM SEWER

UTILITY CROSSING

ELECTRICAL CABLE

GRANULAR TRENCH BACKFIL

**ELECTRICAL TRANSFORMER** 

POWER POLE WITH LIGHT

SANITARY SEWER

CLEANOUT

**PROPOSED** 

**CONTACTS** 

VICE PRESIDENT & PRINCIPAL

OAK BROOK, ILLINOIS 60523

BRIAN JOHNSON, PE, CPESC

DIRECTOR OF ENGINEERING

EAST DUNDEE, IL 60118

(847) 551-5301

ALAN WENDERSKI

1900 HASSELL ROAD

1051 E MAIN STREET, SUITE 217

**VILLAGE OF HOFFAMN ESTATES** 

HOFFMAN ESTATES, ILLINOIS 60169

**VILLAGE OF HOFFMAN ESTATES** 

HOFFMAN ESTATES, ILLINOIS 60169

**UTILITY CONTACTS** 

DIRECTOR OF PUBLIC WORKS

2305 PEMBROKE DRIVE

(847) 490-6800

CABLE TELEVISION

COMCAST CABLE (630) 600-6352 PHONE

(800) 334-7661

NATURAL GAS

(888) 642-6748

(800) 244-4444

68 AND IL RT 53.

DATUM: NAVD88

ELEVATION: 738.25

SIDE OF HIGGINS ROAD.

ELEVATION: 809.70

**TELECOMMUNICATIONS** 

**BENCHMARKS** 

THE VILLAGE LIMITS OF ARLINGTON HEIGHTS IN

SECTION 7, T42N, R11E. STATION IS LOCATED IN THE

SOUTHEAST CORNER OF THE INTERSECTION OF IL RT

SQUARE CUT ON SOUTH SIDE OF LIGHT POLE BASE

EXISTING TOPOGRAPHY SHOWN REPRESENTS SITE

ENGINEERING GROUP, LTD., INC. ON JUNE 10, 2025.

HORIZONTAL AND VERTICAL SITE FEATURES AND

NOTIFY ENGINEER OF ANY DISCREPANCIES PRIOR

CONDITIONS AS PREPARED BY PINNACLE

TO STARTING CONSTRUCTION.

CONTRACTOR SHALL FIELD CHECK EXISTING

CONDITIONS PRIOR TO CONSTRUCTION AND

LOCATED PARKING LOT AND SIDEWALK ON THE NORTH

1211 W. 22nd STREET, SUITE 705

PINNACLE ENGINEERING GROUP, LLC

**FGM ARCHITECTS** 

BASE LINE NORMAL WATER LEVEL POINT OF CURVATURE POINT OF TANGENCY RIGHT-OF-WAY SANITARY SEWER

PINNACLE ENGINEERING GROUP

LONG CHORD OF CURVE CURB AND GUTTER CATCH BASIN CENTERLINE DEGREE OF CURVE EDGE OF PAVEMENT FINISHED FLOOR STORM SEWER TANGENCY OF CURVE FINISHED GRADE TOP OF BANK FLOODPLAIN TOP OF CURB TOP OF FOUNDATION FLOODWAY TOP OF PIPE HIGH WATER LEVE TOP OF SIDEWALK TOP OF WALK LENGTH OF CURVE WATER MAIN

POINT OF VERTICAL INTERSECTION

INTERSECTION ANGLE

PLAN I DESIGN I DELIVER

**HOFFMAN ESTATES FIRE STATION 22** 2190 W. HIGGINS ROAD HOFFMAN ESTATES, IL


**REVISIONS** 

**COVER SHEET** 

SHEET

**COVER SHEET** 

**C-1** 

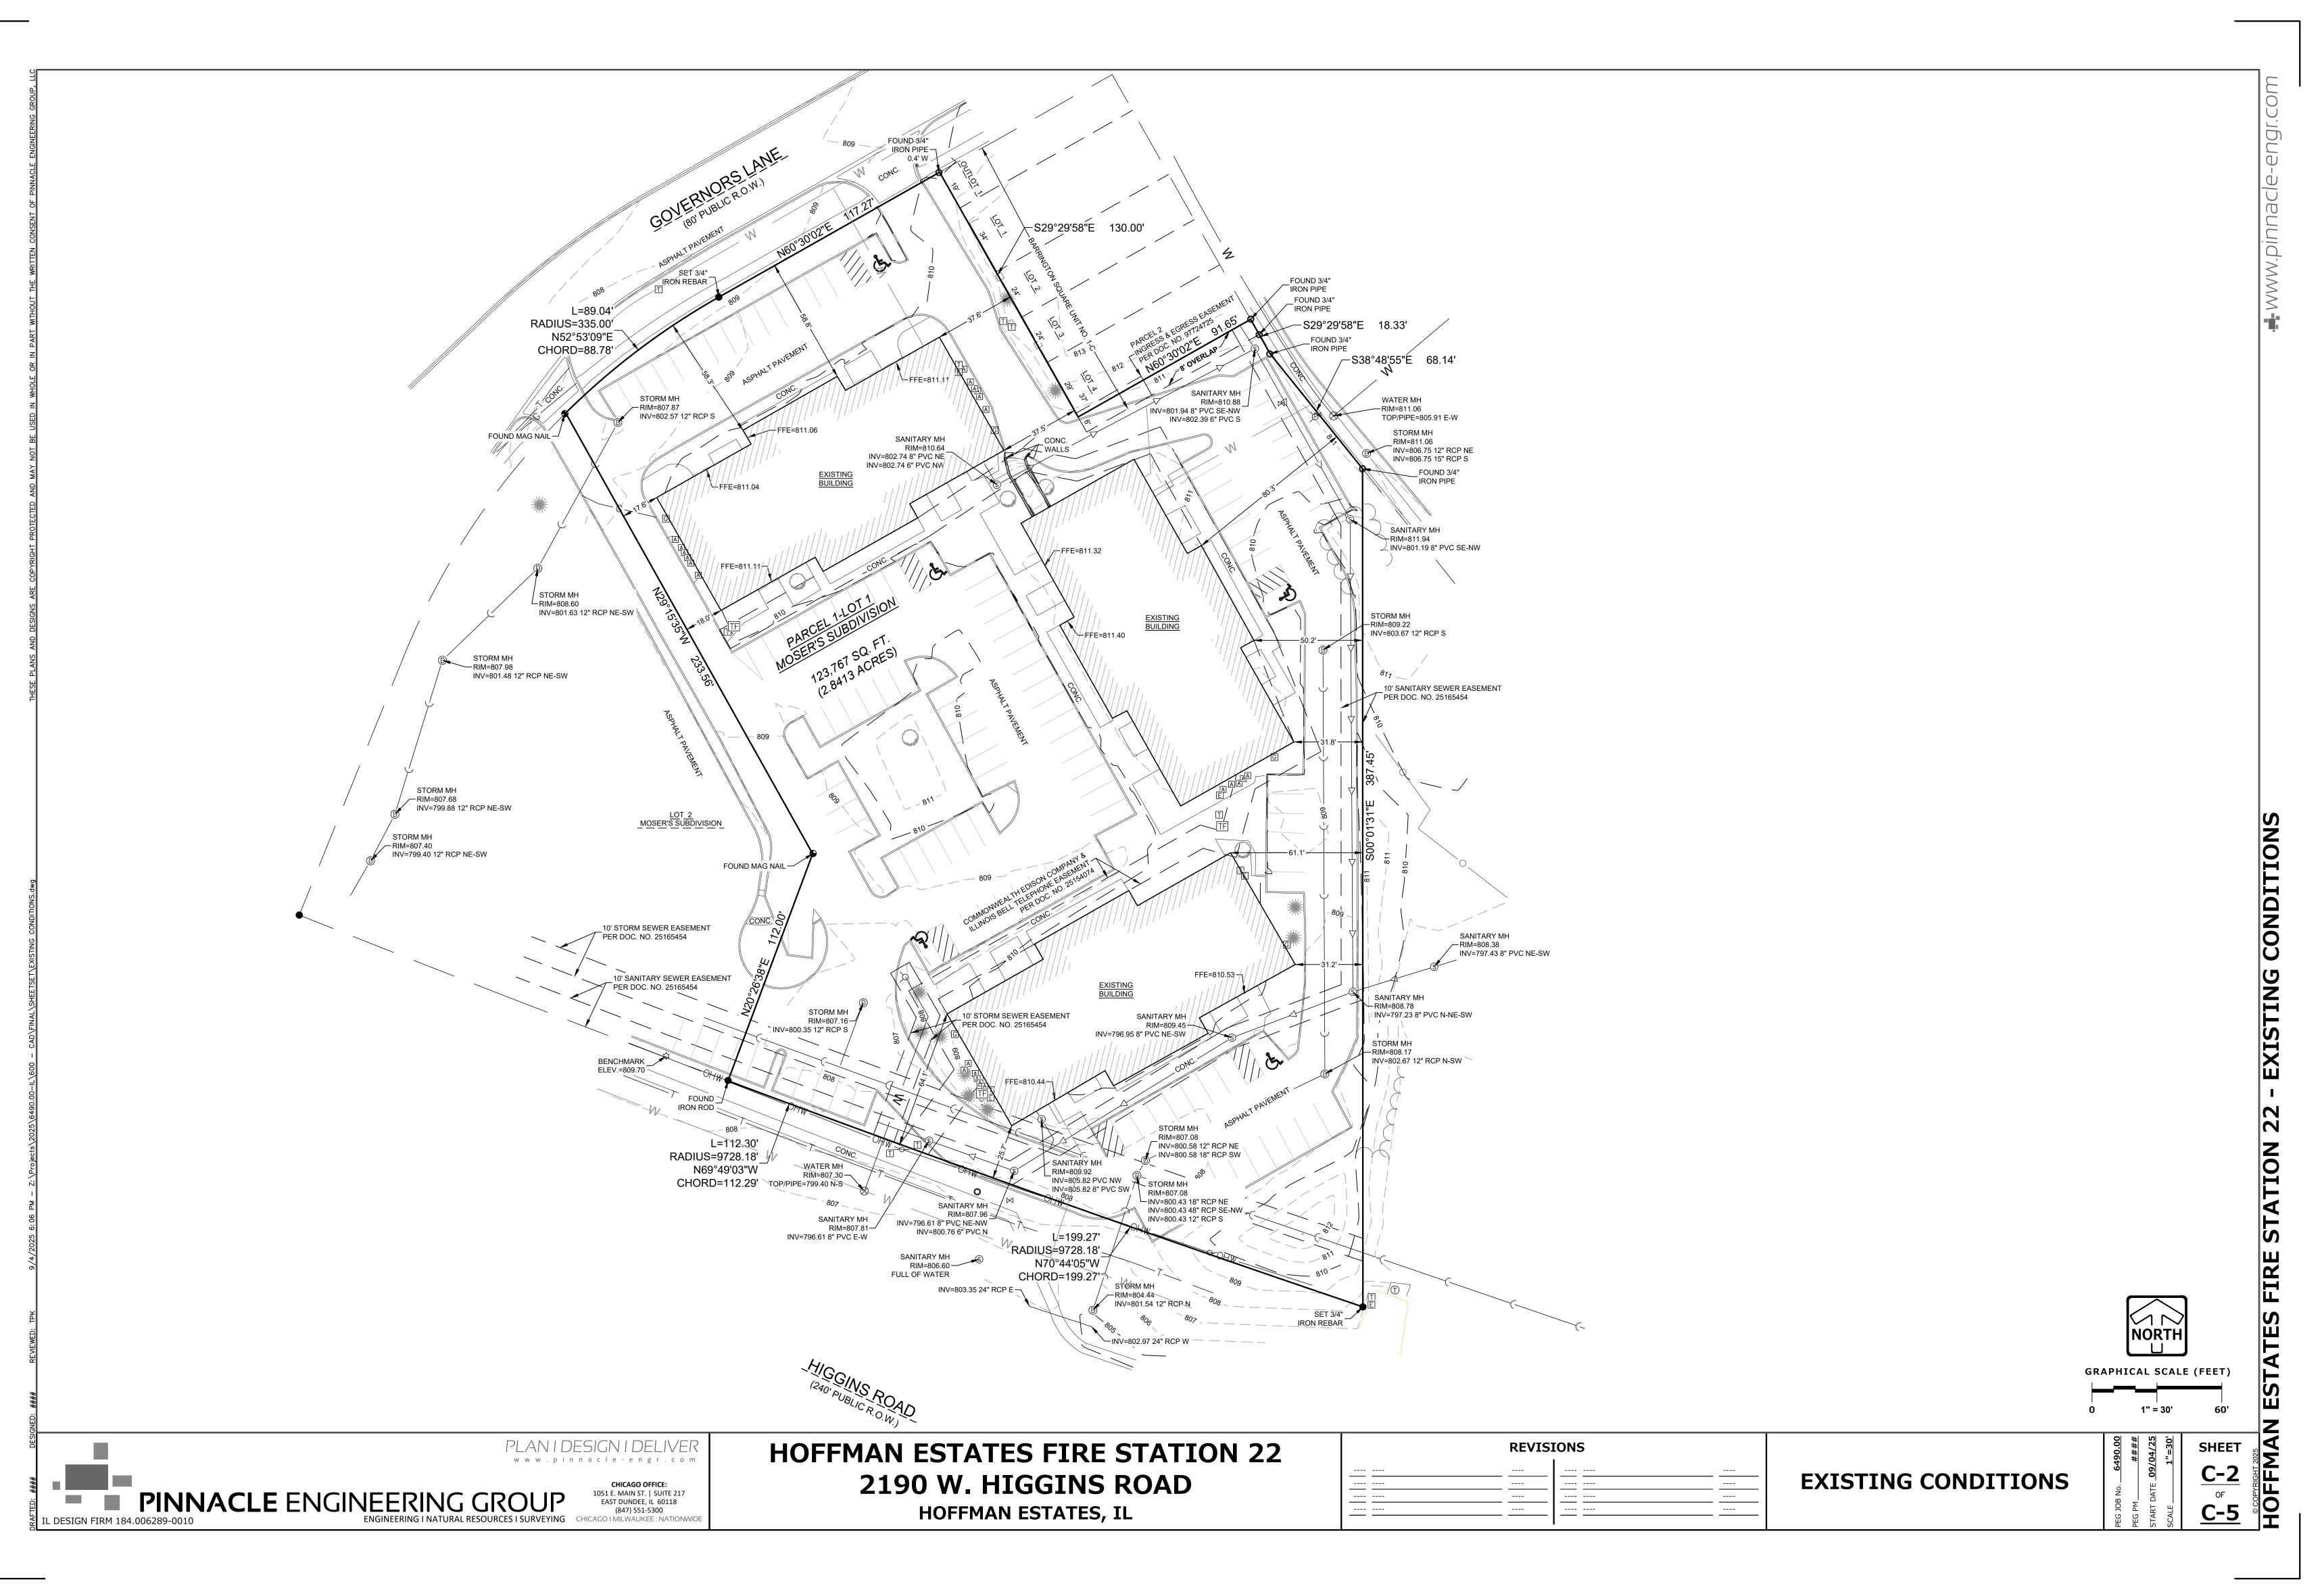

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ILSTATE CERTIFICATE OF AUTHORITY
NO. 184.006289-0010035.03296

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ISSUANCE
NO DATE DESCRIPTION


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**DEFMAN ESTATES FIRE STATION 22**LAGE OF HOFFMAN ESTATES

O W HIGGINS RD, HOFFMAN ESTATES, IL 60169

**EXISTING CONDITIONS** 

**C-2** 

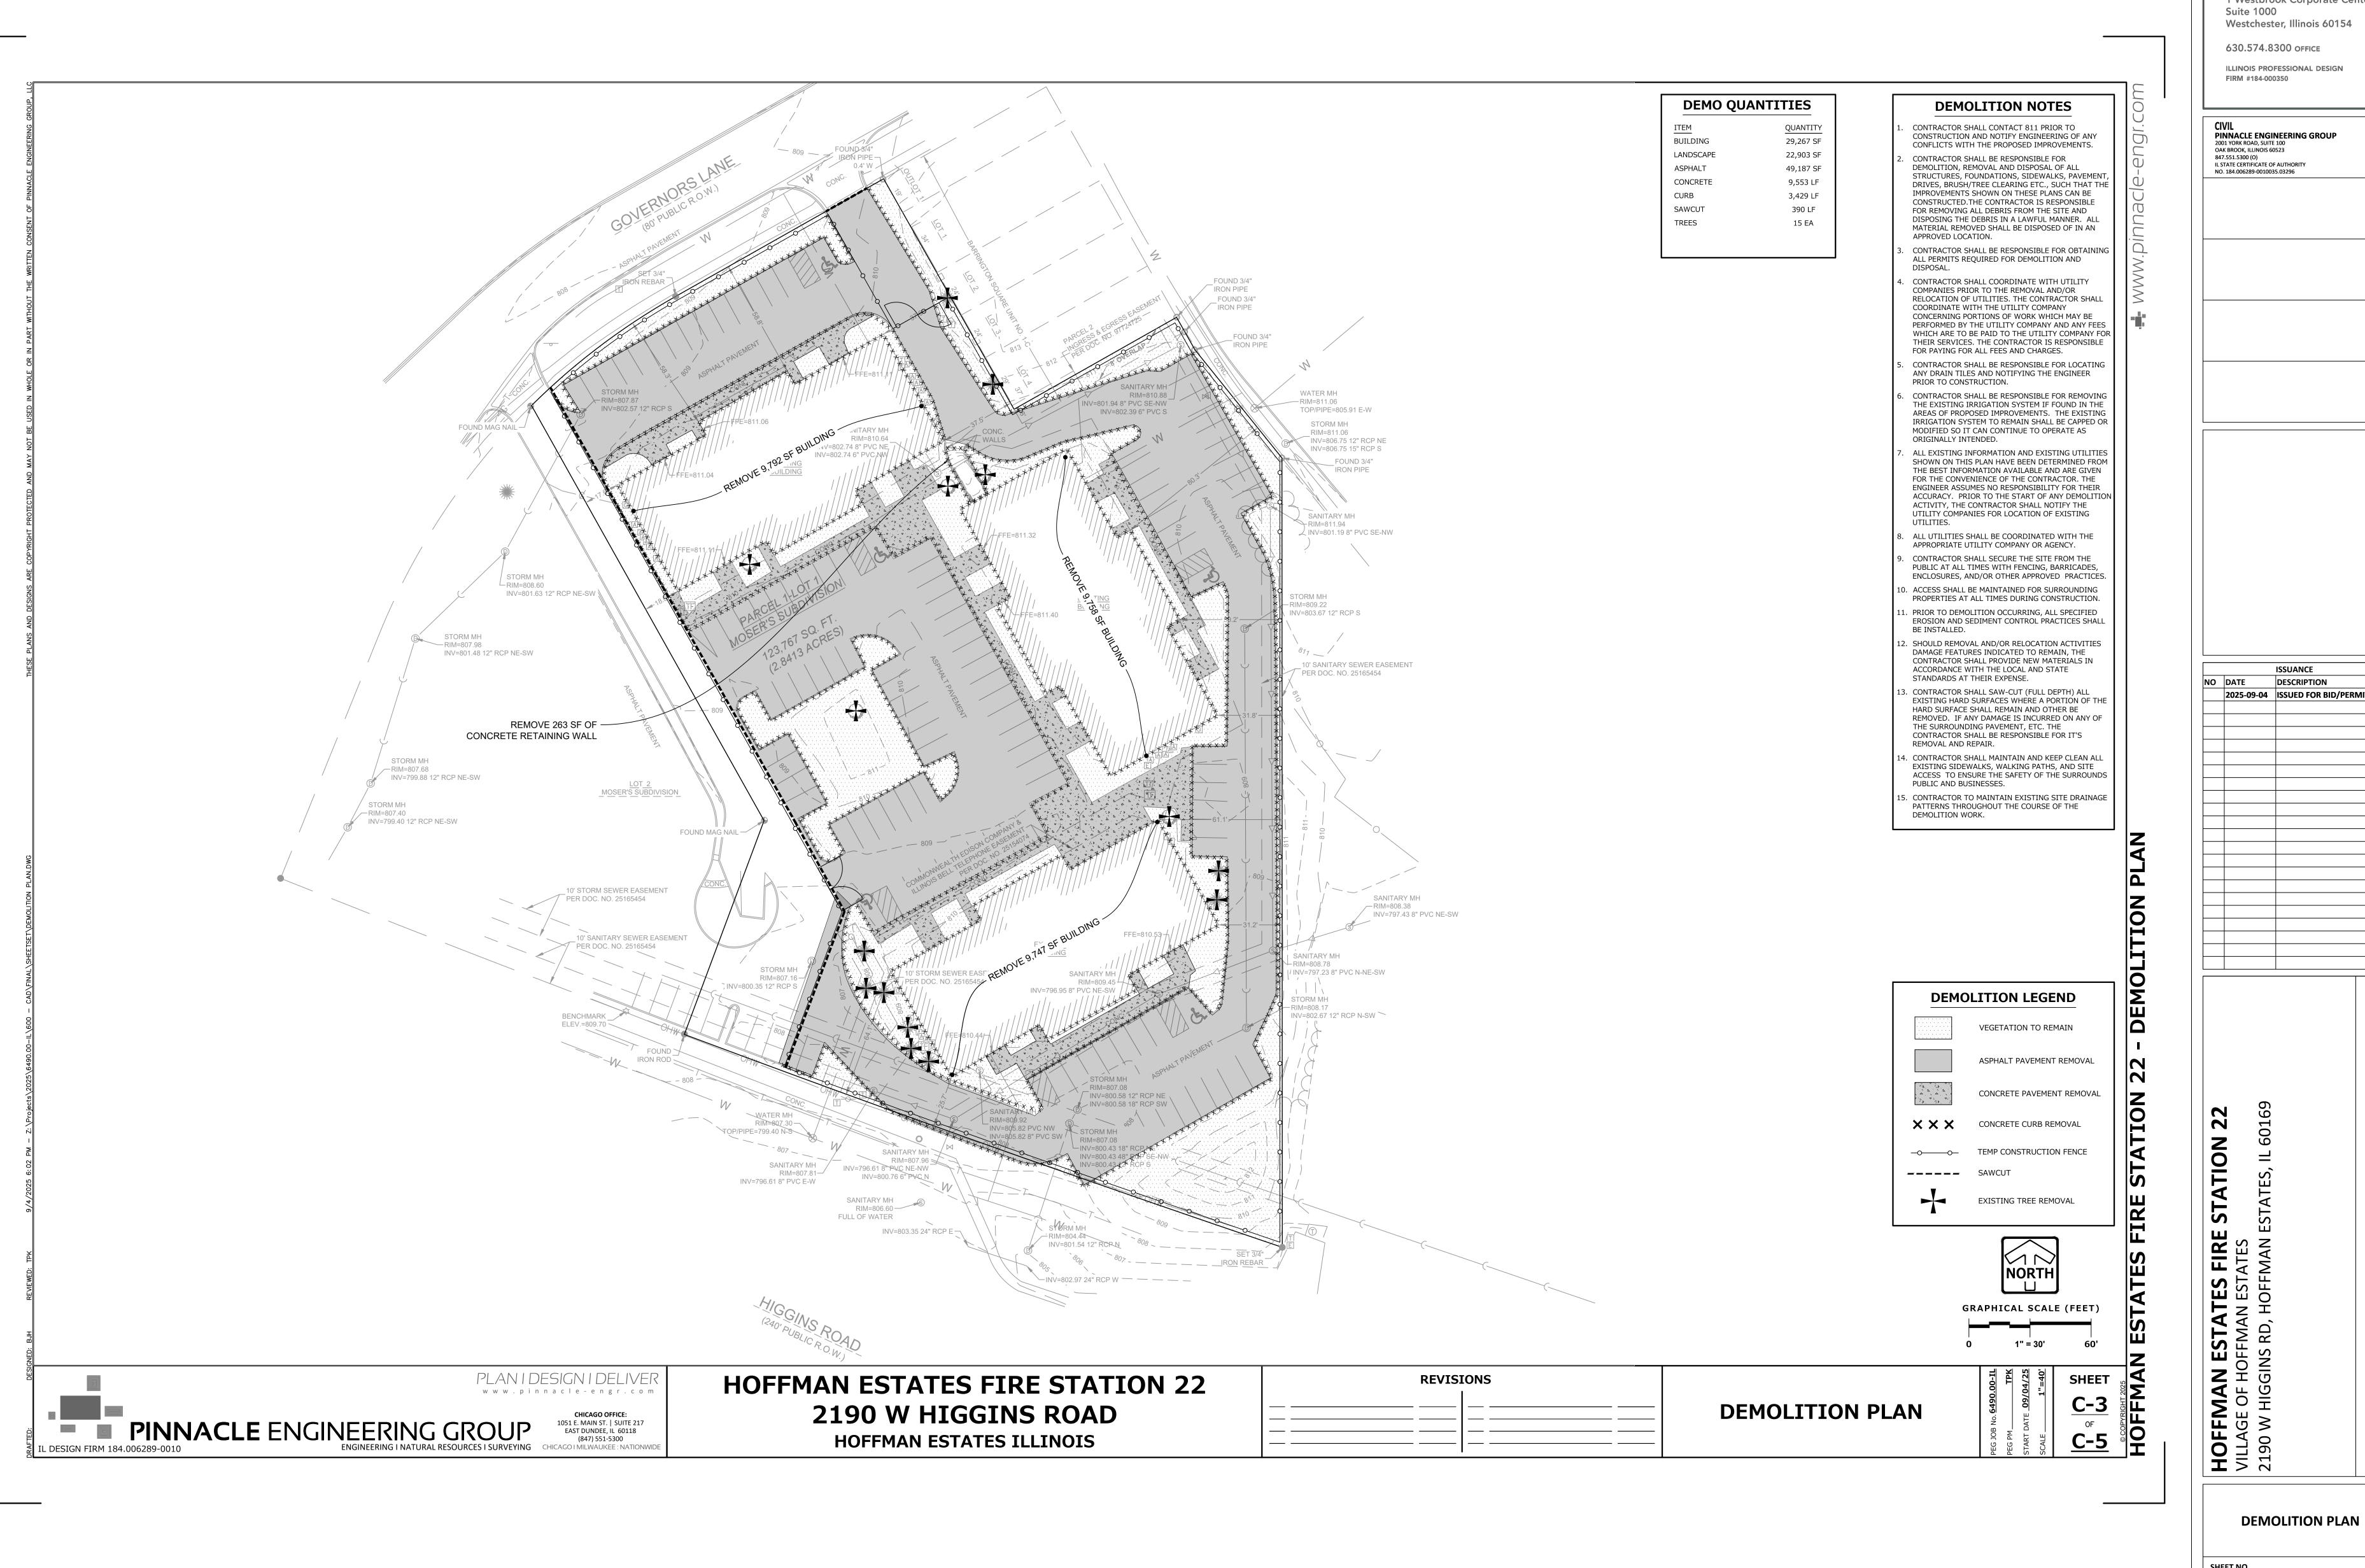

**FGM Architects** 1 Westbrook Corporate Center


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**C-3** 

**JOB NO.** 25-4283.01

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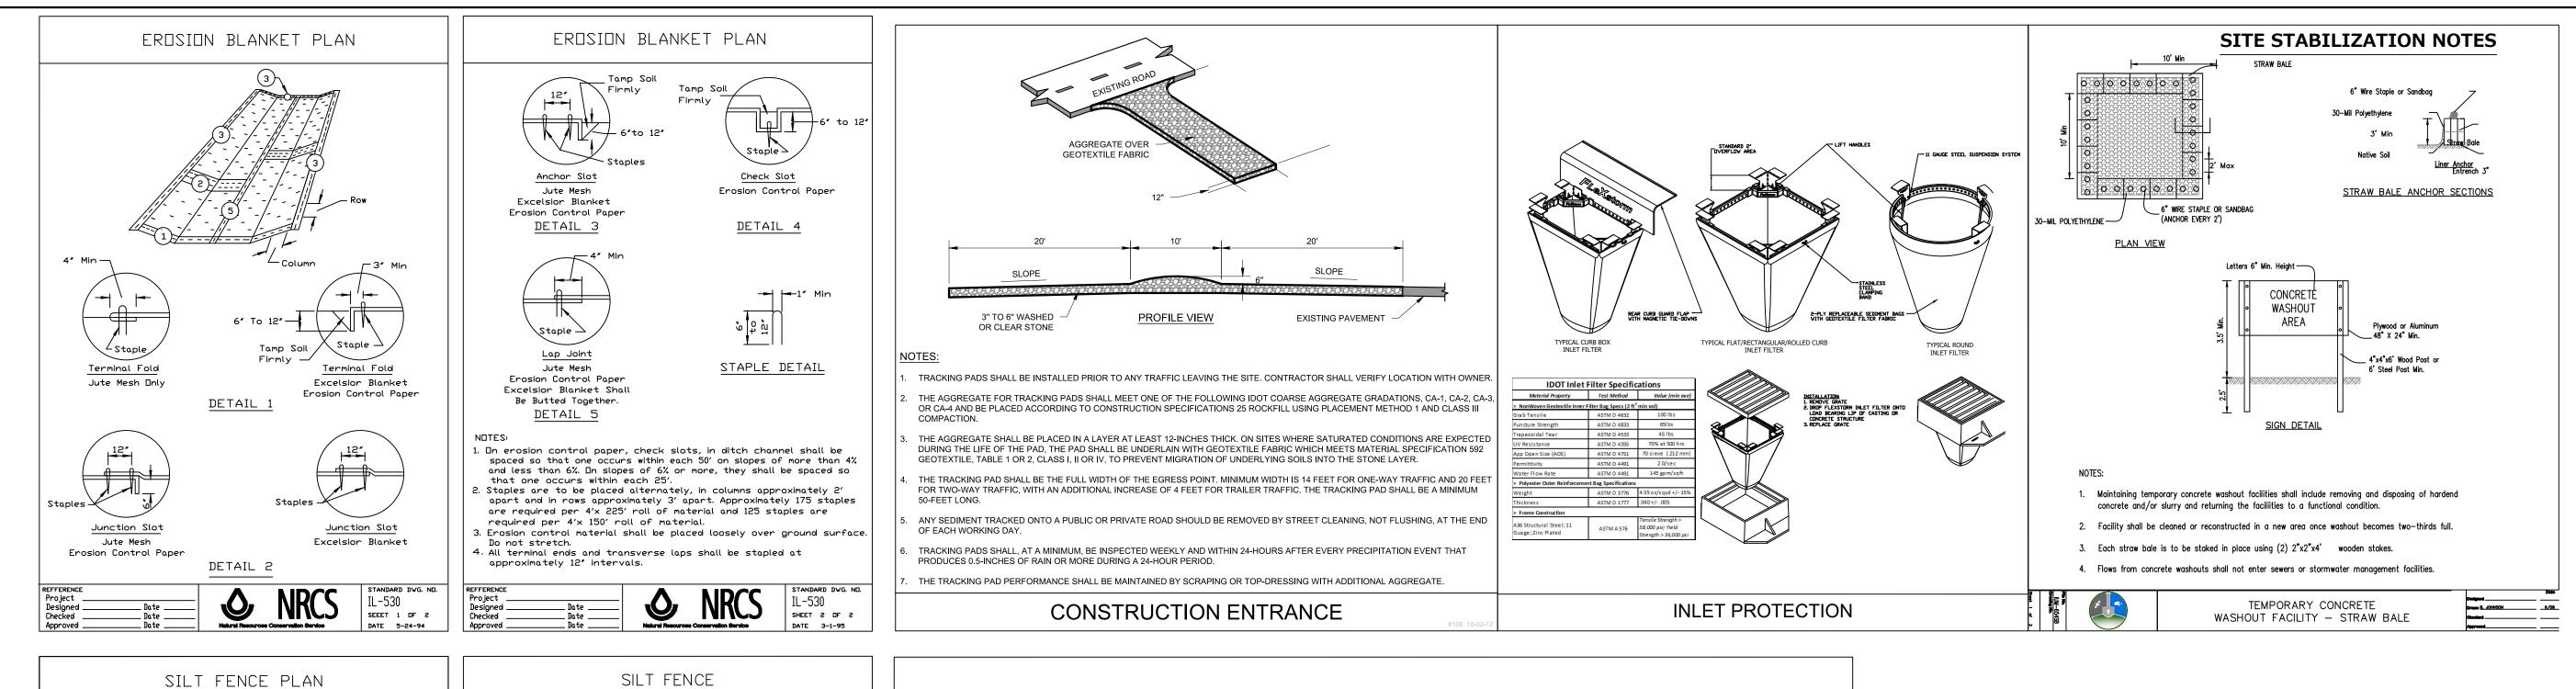
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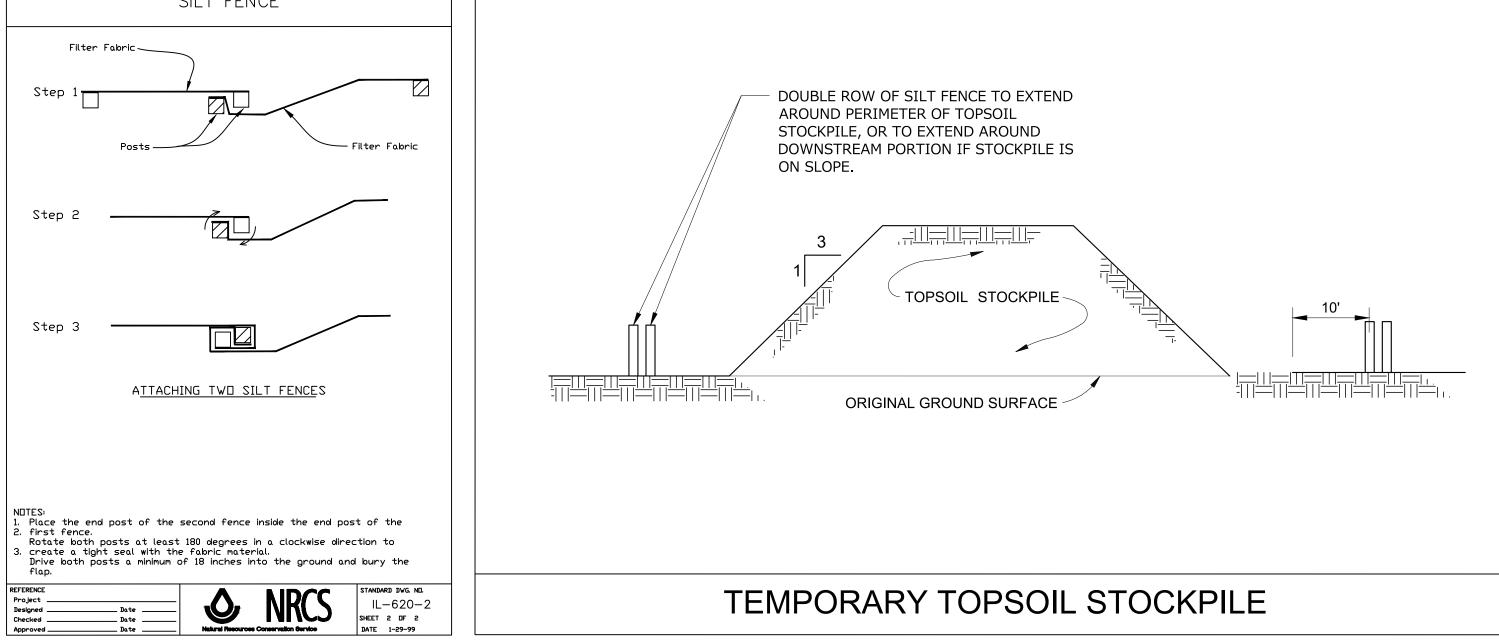
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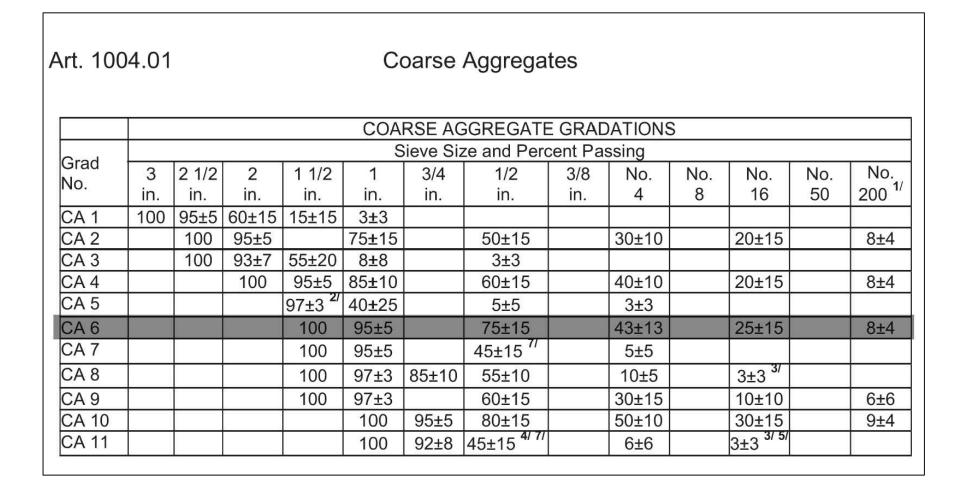
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		2025-09-04	ISSUED FOR BID/PEI	F

SITE STABILIZATION **PLAN** 

**C-4** 

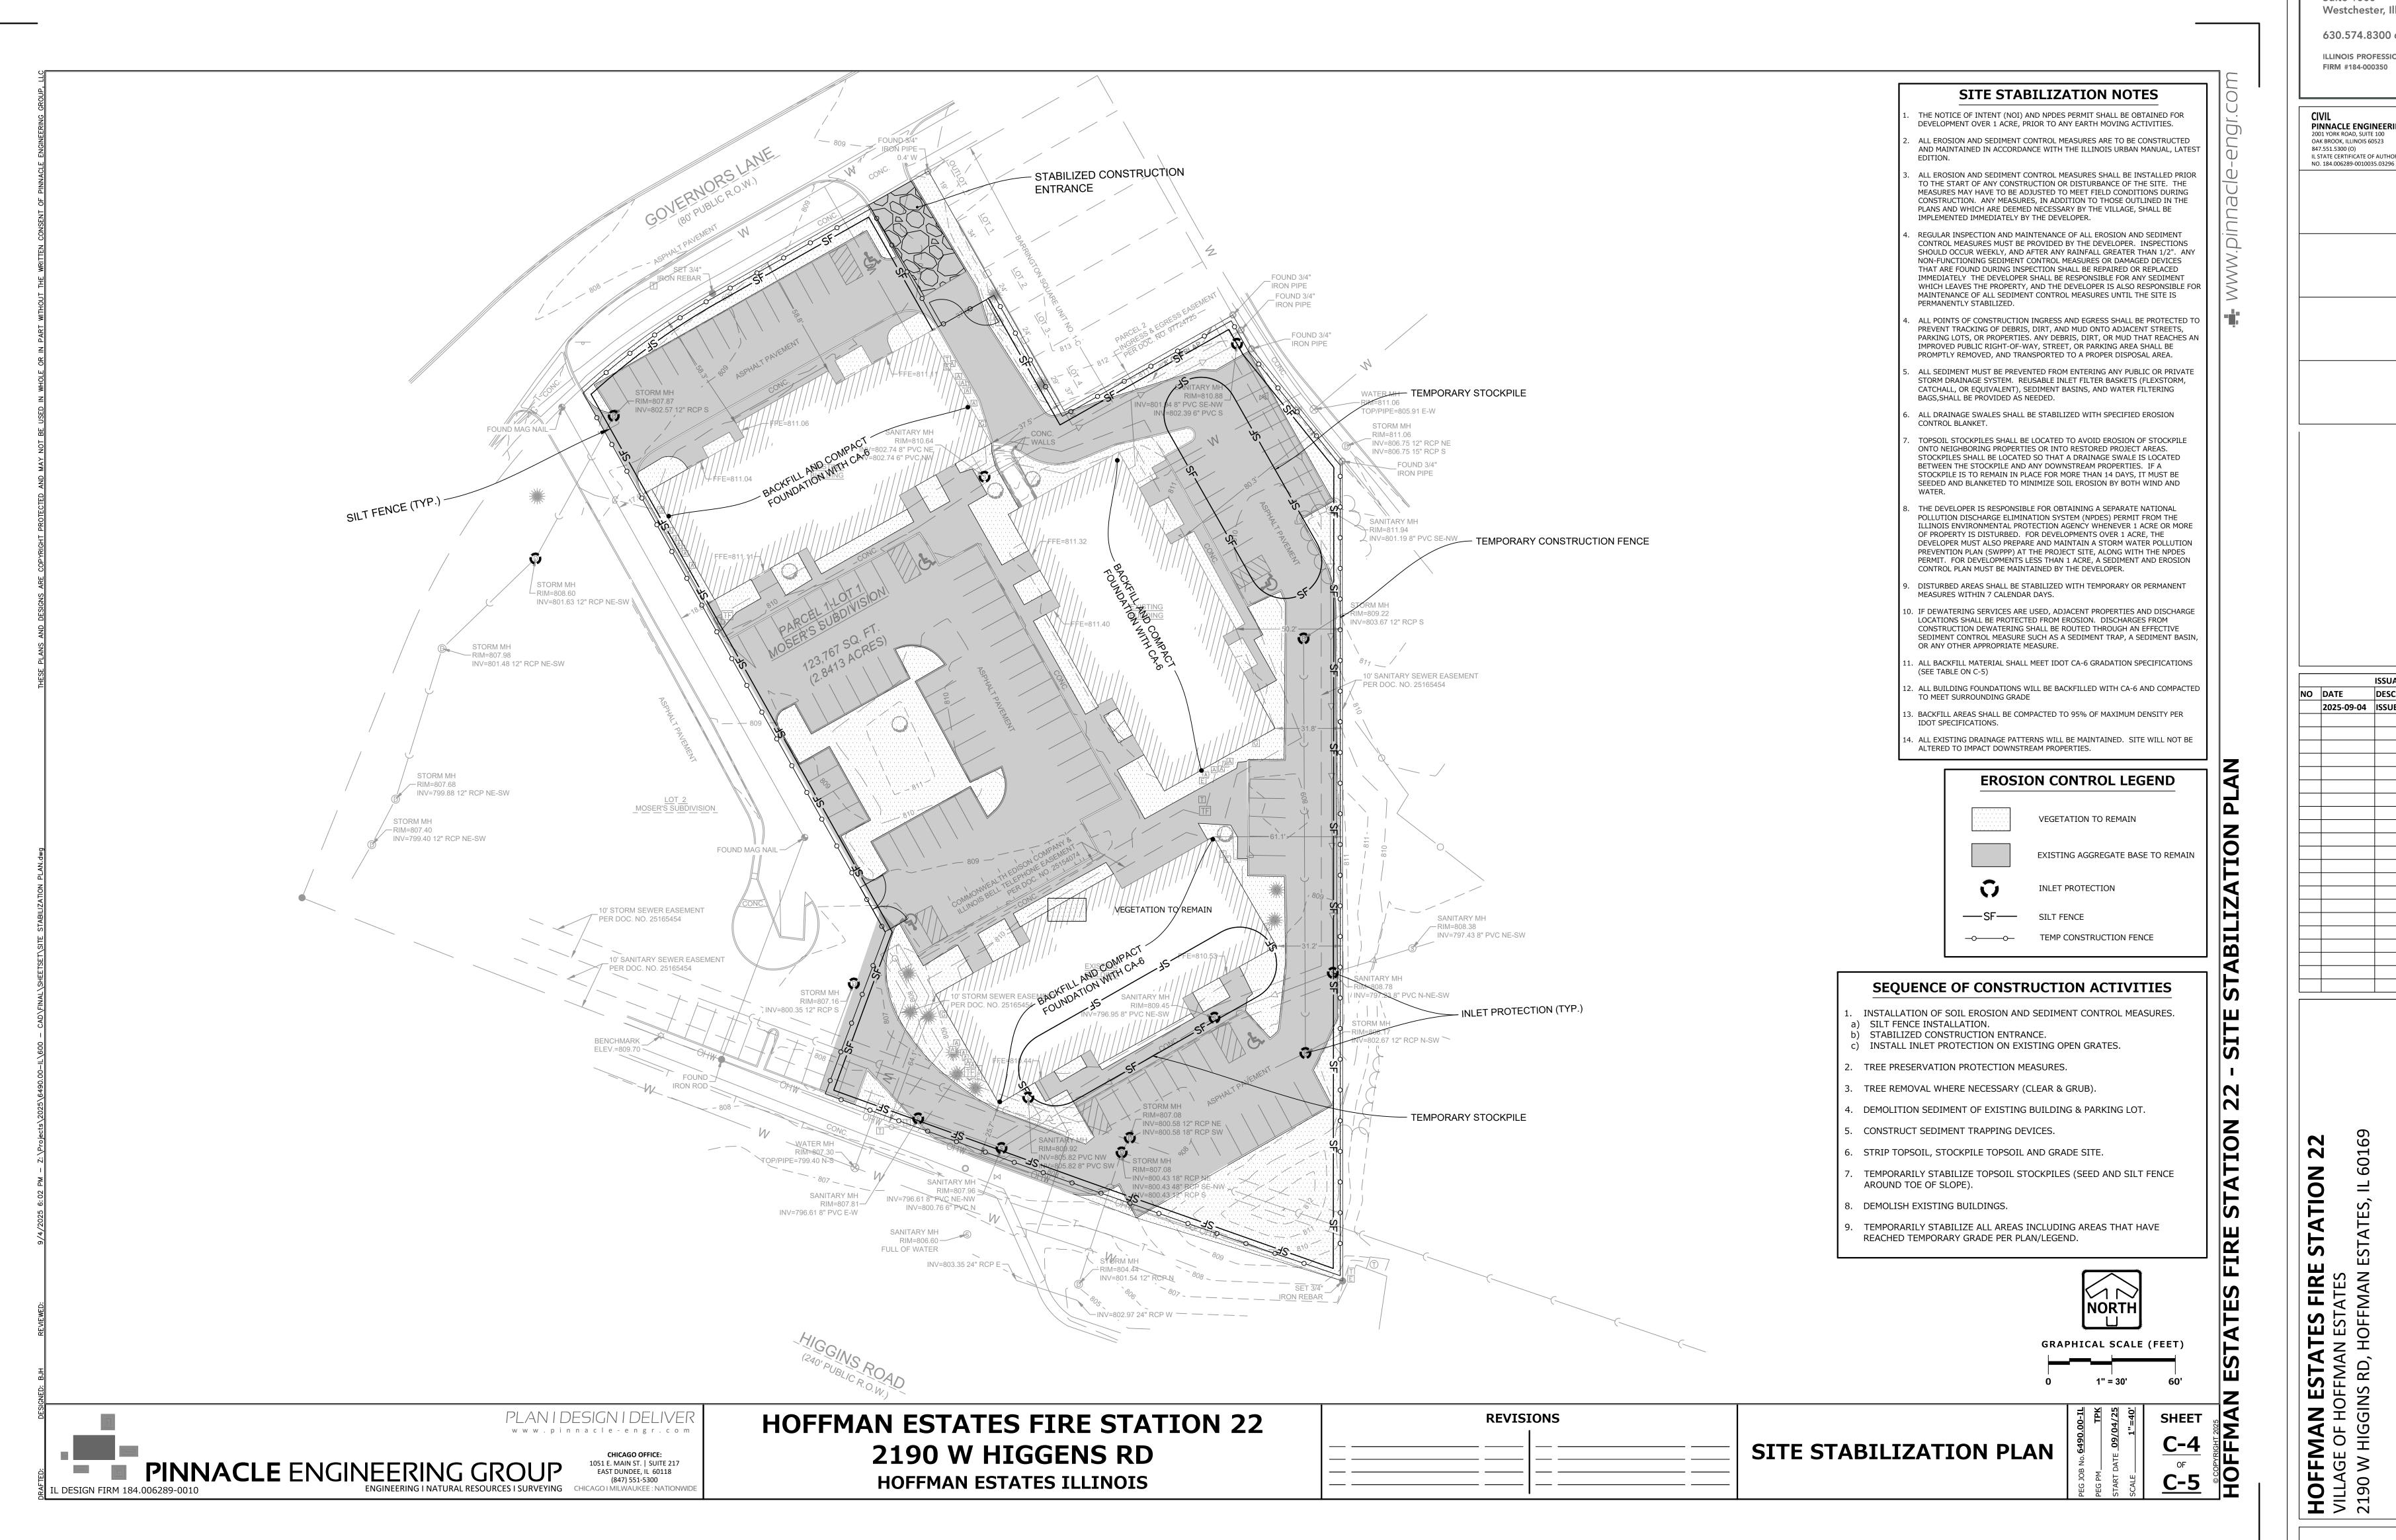





www.pinnacle-engr.com

▼Filter Fabric

and site stabilization.

Fastener – Min. No. 10 Gage Wire

\_\_\_ Direction Of Flow

FABRIC ANCHOR DETAIL

NUTES:

1. Temporary sediment fence shall be installed prior to any grading work in the area to be protected. They shall be maintained throughout the construction period and removed in conjunction with the final grading

2. Filter fabric shall meet the requirements of material specification 592 Geotextile Table 1 or 2, Class I with equivalent opening size of

3. Fence posts shall be either standard steel post or wood post with a

at least 30 for nonwoven and 50 for woven.

minimum cross-sectional area of 3.0 sq. in.

4 Per Post Required. (Typ.)

IL-620

PINNACLE ENGINEERING GROUP

**HOFFMAN ESTATES FIRE STATION 22** 2190 W. HIGGINS ROAD HOFFMAN ESTATES, IL

REVISIONS						
	<del> </del>					

CONSTRUCTION **STANDARDS** 

SHEET	"=30'	09/04/25
<u>C-5</u>	1	
OF		DATE
<u>C-5</u>	SCALE.	START DATE

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NO DATE

**CONSTRUCTION STANDARDS** 

7

**C-5** 

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- 1. EXISTING BUILDINGS TO BE REMOVED IN THEIR ENTIRETY, INCLUDING BUT NOT LIMITED TO FOUNDATIONS, FOOTINGS, ASSOCIATED UTILITIES, ETC. COORDINATE
- 2. REMOVE EXISTING UTILITY PIPING AND CONDUIT TO 5'-0" OUTSIDE FACE OF BUILDING FOUNDATION WALL. COORDINATE WITH CIVIL DRAWINGS.
- 3. REMOVE ALL DEBRIS FROM SITE ON A DAILY BASIS AND DISPOSE OF LEGALLY. CRUSHED CONCRETE AND MILLED ASPHALT TO REMAIN ON SITE AND BE USED FOR
- FILL. COORDINATE WITH CM AND CIVIL. 4. DASHED LINES INDICATE MATERIAL TO BE REMOVED. REMOVE CONSTRUCTION UP
- TO DEFINED LIMITS. REFER TO SHEET KEYNOTES FOR SPECIFIC INFORMATION. 5. OWNER'S ABATEMENT CONTRACTOR TO PERFORM ASBESTOS ABATEMENT OR OTHER HAZARDOUS OR TOXIC SUBSTANCE REMOVAL WORK INDICATED, IN ACCORDANCE WITH SPECIFICATIONS AND WITH AUTHORITIES HAVING JURISDICTION,
- PRIOR TO STARTING GENERAL DEMOLITION ACTIVITIES. 6. FOR DETAILED CIVIL DEMOLITION NOTES, REFER TO CIVIL DRAWINGS.
- COORDINATION WITH NICOR.
- 8. EXISTING TRANSFORMERS ASSOCIATED WITH BUILDINGS TO BE REMOVED IN COORDINATION WITH COMED.
- 10. DISCONNECT ALL ELECTRICAL ASSOCIATED WITH BUILDINGS. 11. EXISTING SITE TO BE CLEARED AND GRUBBED IN ITS ENTIRETY. (ALL GRASSY AREAS

# GENERAL DEMOLITION NOTES

### **DEMOLITION PLAN KEYNOTES**

- REMOVE BUILDING IN ITS ENTIRETY, INCLUDING
- FOUNDATIONS/FOOTINGS, UTILITIES, AND BASEMENT IF APPLICABLE PHASE 1 REMOVAL OF EXISTING PAVEMENT, CONCRETE CURBS, AND GUTTERS IN THEIR ENTIRETY.
- REMOVE SIDEWALK IN ITS ENTIRETY. REMOVE EXISTING CONCRETE RAMP/RETAINING WALLS LEADING TO
- BASEMENT OF BUILDING 2 IN ITS ENTIRETY REMOVE ALL EXISTING HVAC AND ELECTRICAL EQUIPMENT ASSOCIATED
- WITH BUILDING. PHASE 2 PAVEMENT REMOVAL: TIMING/SCHEDULING OF EXISTING
- PAVEMENT ON SHARED DRIVE TO BE COORDINATED WITH CM. EXISTING TRANSFORMER TO REMAIN. PROTECT DURING CONSTRUCTION.
- EXISTING STORMWATER AND SANITARY STRUCTURES TO BE PROTECTED DURING CONSTRUCTION. REFER TO CIVIL DRAWINGS FOR
- EXISTING FIRE HYDRANT TO REMAIN AND BE PROTECTED DURING CONSTRUCTION.
- EXISTING TREELINE ALONG PROPERTY LINE TO REMAIN AND BE PROTECTED DURING CONSTRUCTION. COORDINATE WITH CM.
- REMOVE EXISTING ACCESSIBLE PARKING SIGN IN ITS ENTIRETY.

## **DEMOLITION SITE PLAN LEGEND**

PROPERTY LINE SETBACK LINE

COMED AND TELEPHONE EASEMENT

STORM SEWER EASEMENT

SHARED ACCESS EASEMENT

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**DEMOLITION SITE PLAN** 


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1 DEMOLITION SITE PLAN
1" = 30'-0"

**CONSTRUCTION SITE PLAN LEGEND** 

PROPERTY LINE



8'-0" H POST TEMPORARY CONSTRUCTION FENCE CONSTRUCTION SILT FENCE

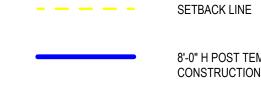



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CONSTRUCTION STAGING SITE PLAN

**AD0.2**